



M.E. RINKER, Sr. HALL
SCHOOL OF BUILDING CONSTRUCTION
 UNIVERSITY OF FLORIDA-GAINESVILLE
 PROJECT NO. BR-191

ARCHITECTS
CROXTON COLLABORATIVE/
GOULD EVANS ASSOCIATES

CROXTON COLLABORATIVE ARCHITECTS
 475 5TH AVENUE
 NEW YORK, NY 10017
 TEL 212.683.1998
 FAX 212.683.2799

GOULD EVANS ASSOCIATES
 5405 WEST CYPRESS STREET
 TAMPA, FL 33607
 TEL 813.288.0729
 FAX 813.288.0231

MECHANICAL ENGINEERS
LEHR ASSOCIATES
 130 WEST 30TH STREET
 NEW YORK, NY 10001-4092
 TEL 212.947.8050
 FAX 212.967.2059

STRUCTURAL ENGINEERS
WALTER P. MOORE AND ASSOCIATES, INC.
 Florida Engineering Business No. 3693
 201 EAST KENNEDY BOULEVARD
 TAMPA, FL 33602
 TEL 813.221.2424
 FAX 813.221.2289

CIVIL ENGINEERS
BROWN & CULLEN, INC.
 3530 NW 43 STREET
 GAINESVILLE, FL 32605
 TEL 352.375.8999
 FAX 352.375.0833

LANDSCAPE ARCHITECTS
McCLAIN DESIGN GROUP, INC.
 1843 NW 39 DRIVE
 GAINESVILLE, FL 32605
 TEL 352.372.2808
 FAX 352.375.6822

CONSULTANT
SEEGY-BISCH
 AUSSERE SULZBACHER STR. 118
 NURNBERG, GERMANY
 TEL 0911/59 90 99
 FAX 0911/59 98 05


THIS DRAWING, AS AN INSTRUMENT OF SERVICE, IS AND SHALL REMAIN PROPERTY OF CROXTON COLLABORATIVE ARCHITECTS. THIS DRAWING SHALL NOT BE REPRODUCED, PUBLISHED, USED ON OTHER PROJECTS, USED FOR ADDITIONS, OR USED IN COMPLETION OF THIS PROJECT BY OTHERS EXCEPT BY AGREEMENT IN WRITING. © 2001 CROXTON COLLABORATIVE ARCHITECTS/GOULD EVANS ASSOCIATES

NO. ISSUE/REVISION DATE

100% CONSTRUCTION DOCUMENTS


DRAWING NAME
FOUNDATION SLAB-ON-GRADE PLAN

DATE 11-21-01
 SCALE AS NOTED **S1.0**
 DRAWN BY/CHECKED BY LMR/JLD

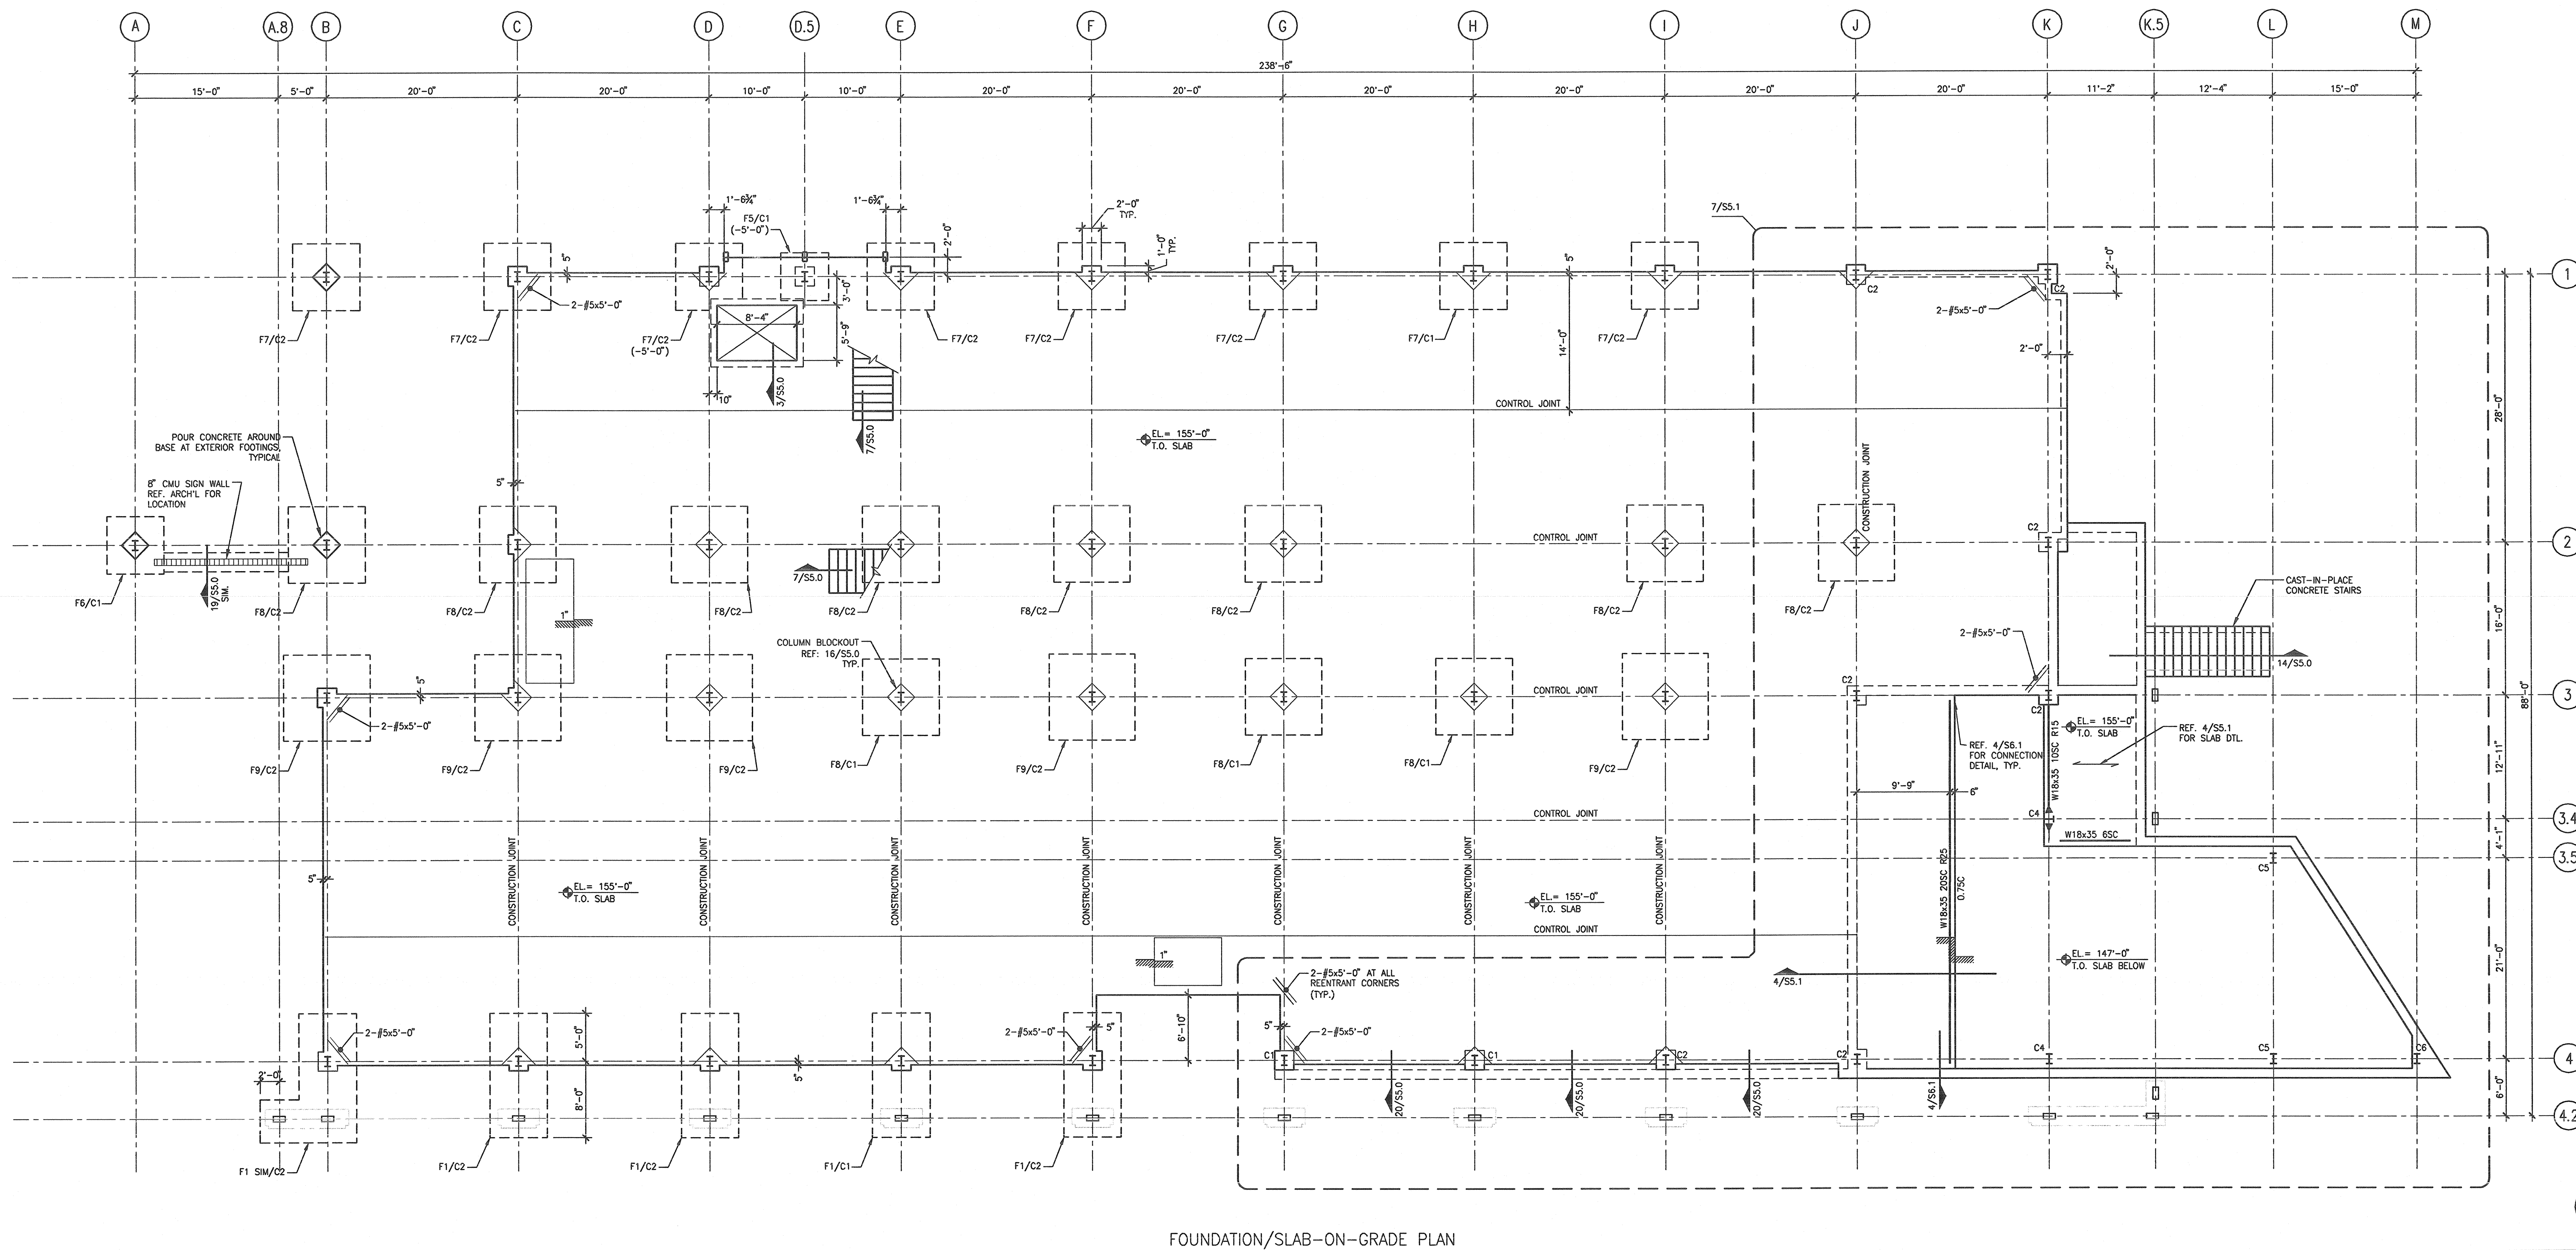

FOUNDATION/SLAB-ON-GRADE PLAN

1 1/8"=1'-0" PLAN

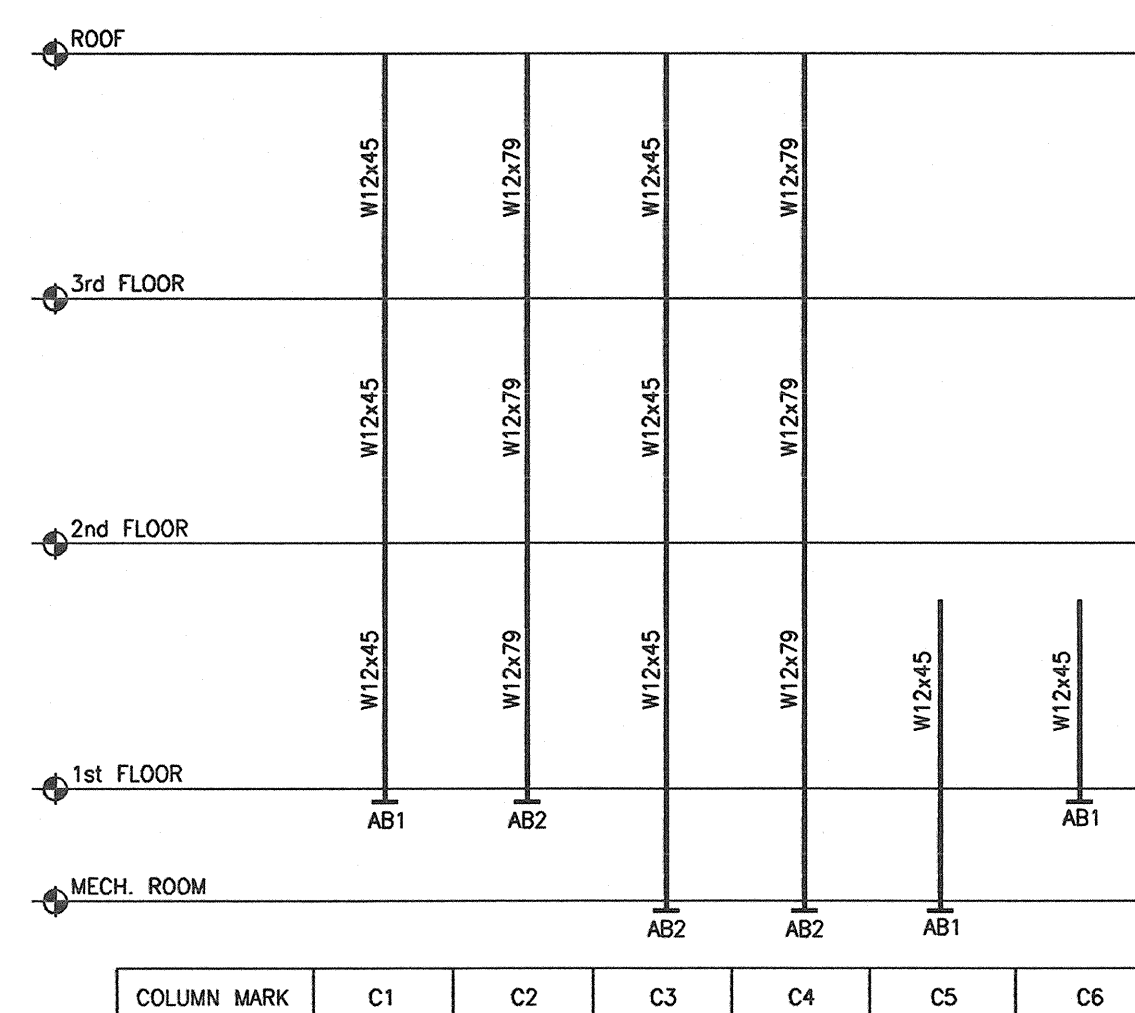

COLUMN SCHEDULE

NOTE:
 1. BASE PLATES TO BE 20x20x1/4 GRADE 50, TYPICAL U.N.O.
 SEE 15/SS.0 FOR PLATE REQUIREMENTS AT CONCRETE FINISH.
 2. REF. 13/SS.0 FOR ANCHOR BOLT SIZE.

4 N.T.S. SCHEDULE

SPREAD FOOTING SCHEDULE					
MARK	SIZE IN PLAN	THICKNESS	REINFORCEMENT EA. WAY		
			BOTTOM	TOP	W/STAIR
F1	6'-0" x 13'-0"	18"	#9 @ 12"	#6 @ 12"	
F5	15'-0" x 12'-0"	18"	#9 @ 12"	#6 @ 12"	
F6	6'-0" x 6'-0"	18"	#6 @ 6"	#6 @ 6"	
F7	7'-0" x 7'-0"	18"	#7 @ 6"	#7 @ 6"	
F8	8'-0" x 8'-0"	24"	#8 @ 7"	#8 @ 6"	
F9	9'-0" x 9'-0"	24"	#9 @ 7"	#9 @ 6"	
F10	10'-0" x 10'-0"	28"	#10 @ 8"	#10 @ 6"	

3 NONE SCHEDULE

- FOUNDATION / S.O.G. NOTES:
- SLAB ON GRADE TO BE 5" THICK, 4000 PSI NORMAL WEIGHT CONCRETE REINFORCED WITH WWF 6x6-W2.9xW2.9 U.N.O. LONG STRIP CONSTRUCTION MUST BE USED, RE 2/SS.0.
 - TOP OF FOOTING ELEVATION TO BE 2'-0" BELOW TOP OF SLAB, TYPICAL U.N.O. WHERE T.O. FOOTING IS GREATER THAN 2'-0" BELOW T.O. SLAB, REF. 16/SS.0.
 - SEE S.S.O FOR TYPICAL FOUNDATION AND SLAB ON GRADE DETAILS.
 - REFER TO ARCHITECTURAL DRAWINGS FOR EXTENT AND DIMENSIONS OF SLAB ON GRADE.
 - REFER TO ARCHITECTURAL DRAWINGS FOR EXTENT AND DIMENSIONS OF DEPRESSED SLAB AREAS, RAMPS AND SLOPES.
 - REFER TO ARCHITECTURAL DRAWINGS FOR ELEVATOR AND STAIR LOCATIONS AND DIMENSIONS.
 - REFER TO ARCHITECTURAL DRAWINGS FOR CMU WALL LOCATIONS.

2 NONE PLAN NOTES